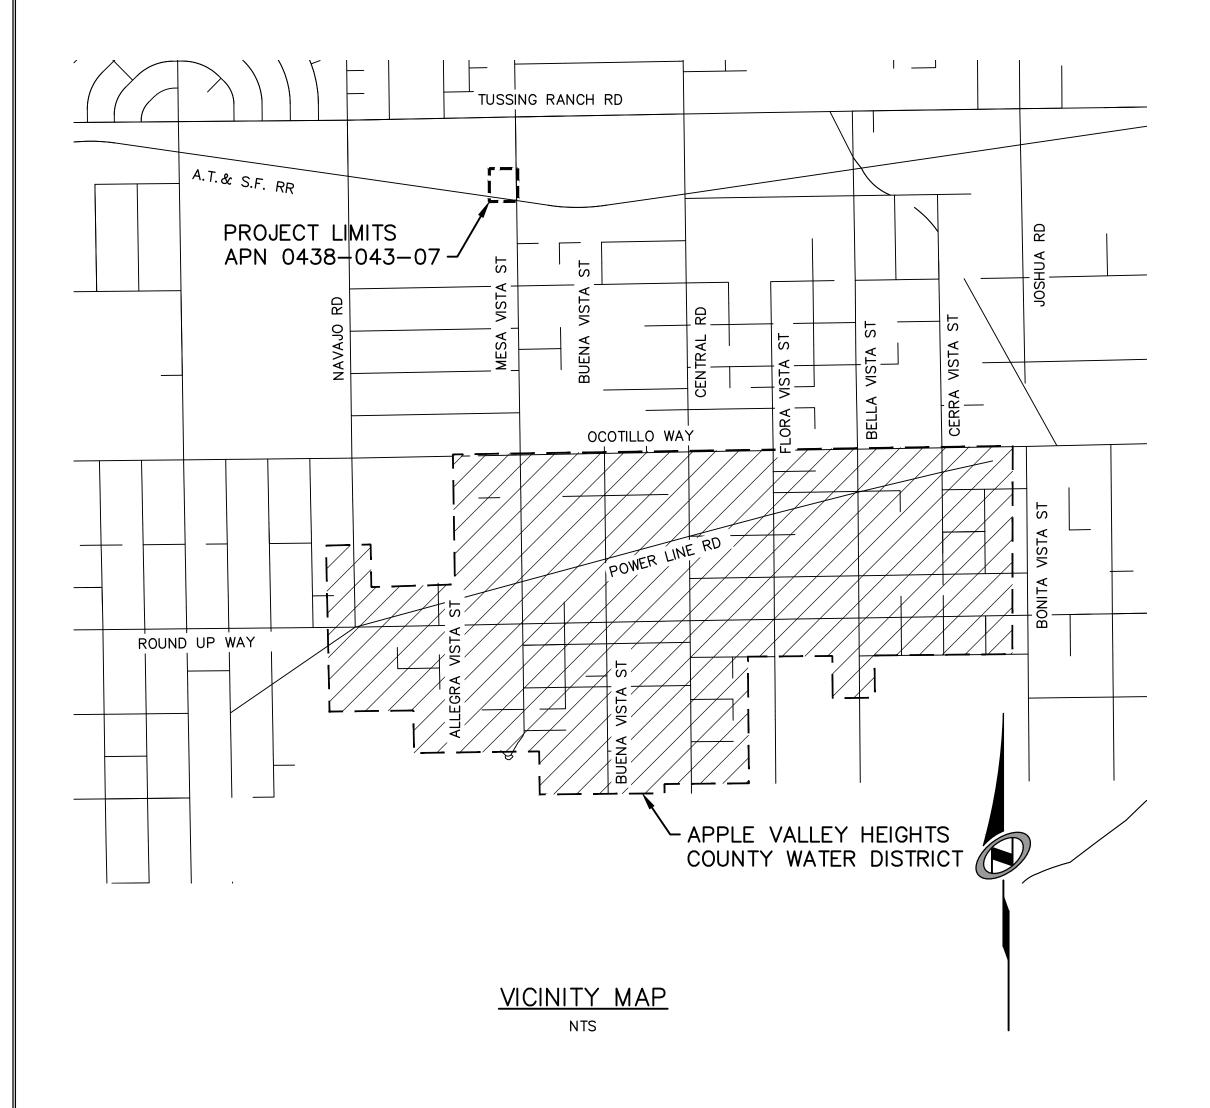
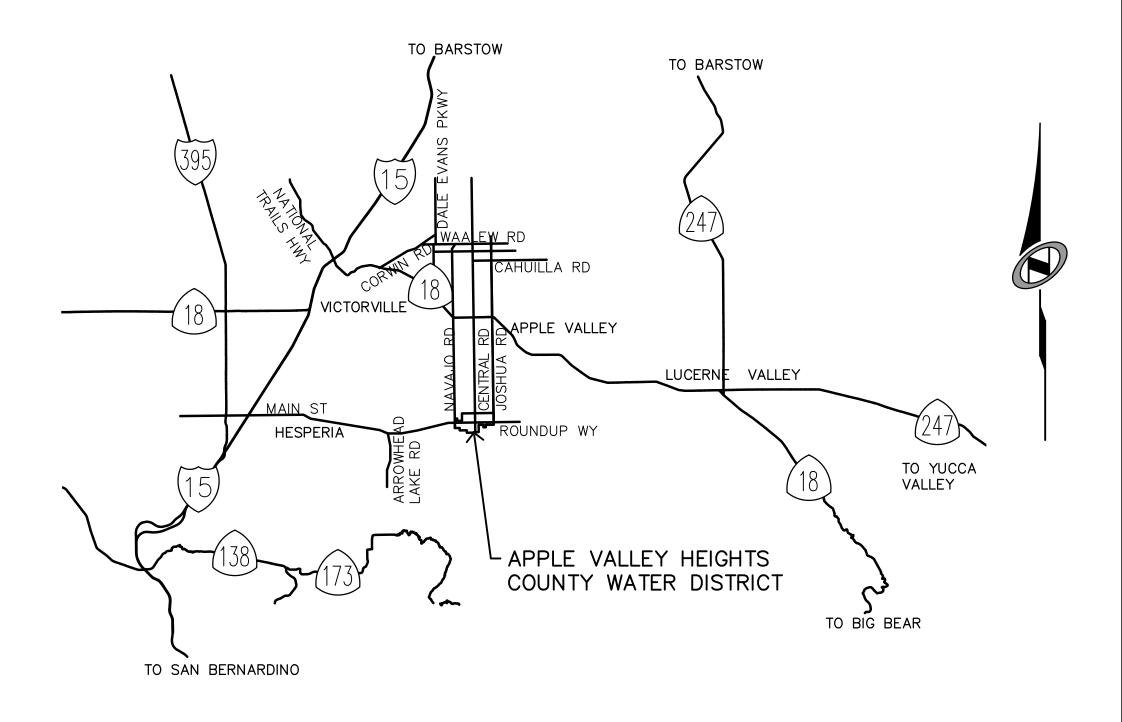
APPLE VALLEY HEIGHTS COUNTY WATER DISTRICT WELL AND BOOSTER PUMP STATION IMPROVEMENTS

30% CONCEPTUAL SEPTEMBER 2019



SHŁŁI	DWG.	
<u>NO:</u>	<u>NO:</u>	DRAWING TITLE:
1	T-01	TITLE SHEET
2	G-01	NOTES, LEGEND, ABBREVIATIONS, KEY MAP
		SURVEY CONTROL
3	C - 01	SITE PLAN
4	M - O1	WELL HOUSE BUILDING DETAILS



LOCATION MAP



DATE: ______9/3/19 _____TIME: _____5:50:01 PM SERVER: NONE LAYOUT: TITLE SHEET PATH: N: \226817-0000211-03\CADD\CIVIL\WELLSITE









NO. BY DATE REVISIONS:

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PRELIMINARY NOT FOR CONSTRUCTION

WELL AND BOOSTER PUMP STATION IMPROVEMENTS SCALE VERTICAL: 1"= N/A HORIZONTAL: 1"= N/A

15092 AVENUE OF SCIENCE, SUITE 200 SAN DIEGO, CA 92128 P: 858.385.0500 WWW.NV5.COM

GENERAL NOTES

- 1. POTABLE WATER WORKS SHALL BE CONSTRUCTED IN ACCORDANCE WITH THE DETAILS AND MATERIALS AS SPECIFIED HEREIN AND PER THE CURRENT STANDARDS OF THE AMERICAN WATERWORKS ASSOCIATION (AWWA). CONTRACTOR SHALL HAVE A COPY OF THE STANDARD SPECIFICATIONS AND SAN BERNARDINO COUNTY PUBLIC WORKS' GENERAL PERMIT CONDITIONS AND TRENCH SPECIFICATIONS (JULY 2017) ON THE JOB SITE AT ALL
- 2. UNLESS OTHERWISE NOTED, CONNECTIONS TO EXISTING PIPELINES SHALL BE MADE DRY. THE TIME AND DURATION OF ANY SHUTDOWNS OF EXISTING MAINS SHALL BE SUBJECT TO APPROVAL BY THE OWNER. OWNER SHALL BE NOTIFIED FIVE WORKING DAYS MINIMUM IN ADVANCE OF ANY SHUTDOWN. SYSTEM VALVES WILL BE OPERATED BY OWNER'S FORCES ONLY.
- 3. CONTRACTOR SHALL COORDINATE WITH OWNER ALL ARRANGEMENTS FOR HIGH-LINING TEMPORARY SERVICES PRIOR TO SHUTDOWNS. NO SHUTDOWNS WILL BE SCHEDULED ON MONDAY, FRIDAY, OR WEEKENDS.
- 4. NO WORK MAY BEGIN OR PROCEED WITHOUT DIRECTION OF OWNER'S INSPECTOR. CONTRACTOR SHALL NOTIFY THE OWNER'S INSPECTOR 48 HOURS PRIOR TO THE BEGINNING OF WORK TO ARRANGE FOR INSPECTION OF THE PROJECT.
- 5. THE CONTRACTOR MUST CALL "DIG ALERT OF SOUTHERN CALIFORNIA" TO HAVE UNDERGROUND SERVICE UTILITIES LOCATED PRIOR TO CONSTRUCTION. THIS CALL WILL BE MADE AT LEAST 48 HOURS IN ADVANCE PRIOR TO ANY WORK BEING PERFORMED IN PUBLIC RIGHT-OF-WAY. (DIG ALERT PHONE: 8-1-1)
- 6. ALL EXISTING FACILITIES WHICH MAY AFFECT PROJECT CONSTRUCTION, I.E., LINE CROSSINGS, LINE PARALLELING. OR PROPOSED CONNECTIONS SHALL BE FIELD VERIFIED BEFORE ANY CONSTRUCTION BEGINS.
- 7. CONTRACTOR SHALL TIE OFF ALL VALVE LOCATIONS AND PROVIDE WRITTEN DIMENSIONS TO INSPECTOR IMMEDIATELY UPON INSTALLATION OF VALVES.
- 8. ALL DESIGN CHANGES TO THE WATER SYSTEM SHALL BE APPROVED BY THE OWNER'S REPRESENTATIVE IN WRITING PRIOR TO CONSTRUCTION AND ACCEPTANCE OF THE CHANGE.
- 9. THE WATER SYSTEM SHALL BE PRESSURE TESTED AND DISINFECTED IN ACCORDANCE WITH THE PROCEDURES IN THE PROJECT SPECIFICATIONS.
- 10. PIPELINES AND APPURTENANCES SHALL BE DISINFECTED IN ACCORDANCE WITH THE PROJECT SPECIFICATIONS PRIOR TO TIE-IN OR CONNECTION TO EXISTING SYSTEM FACILITIES. BACTERIOLOGIC QUALITY TEST RESULTS SHALL CONFORM TO THE CRITERIA SPECIFIED IN THAT SPECIFICATION.
- 11. CONTRACT RECORD DRAWINGS MUST BE SUBMITTED PRIOR TO FINAL ACCEPTANCE OF WORK, THE PLANS MUST PROVIDE POST CONSTRUCTION VERIFICATION OF THE LOCATION AND ELEVATION OF PIPES AND APPURTENANCES.
- 12. CONTRACTOR SHALL GUARANTEE ALL WORK FOR A PERIOD OF ONE (1) YEAR AFTER THE DATE OF ACCEPTANCE FOR THE PROJECT. CONTRACTOR SHALL REPAIR OR REPLACE ANY OR ALL SUCH WORK, TOGETHER WITH ANY OTHER WORK WHICH MAY BE DISPLACED IN SO DOING THAT MAY PROVE DEFECTIVE IN WORKMANSHIP AND/OR MATERIALS WITHIN THE ONE-YEAR PERIOD FROM THE DATE OF ACCEPTANCE WITHOUT EXPENSE WHATSOEVER TO THE OWNER. ORDINARY WEAR AND TEAR. UNUSUAL ABUSE OR NEGLECT EXCEPTED.
- 13. CONTRACTOR SHALL KEEP ACCESS TO DRIVEWAYS AND PRIVATE ROADS OPEN AT ALL TIMES DURING CONSTRUCTION. CONTRACTOR SHALL KEEP NON-SKID STEEL PLATES ONSITE TO COVER EXPOSED TRENCHES AND PROVIDE IMMEDIATE VEHICULAR OR PEDESTRIAN ACCESS.
- 14. CONSTRUCTION SEQUENCING AND FACILITY SHUTDOWN LIMITATIONS ARE ESSENTIAL TO THE EXECUTION OF THE WORK. SEE PROJECT SPECIFICATIONS.
- 15. CONNECTIONS TO EXISTING ASBESTOS CEMENT PIPE SHALL BE MADE BY DISASSEMBLING THE EXISTING AC PIPE JOINT AND NOT CUTTING THE AC PIPE. PROVIDE NEW PVC PIPE SPOOLS AS REQUIRED TO COMPLETE

ABBREVIATIONS

INVERT ELEVATION

G-01.DWG

INCHES

DATE: ______9/3/19 TIME: _____5:52:31 PM

PATH: N: \226817-0000211-03\CADD\CIVIL\WELLSITE

DESIGNER: #### PROJ. MGR: ___

SERVER: NOINES LECENTOUTABBREVIATIONS KEY MAP &

LINEAR FEET

IN (OR ")

DRAWING NAME:

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ADDREY	<u>/IATIONS</u>		
AB AC ALT ANG APPROX AWWA	AGGREGATE BASE ASBESTOS CEMENT ALTERNATE ANGLE APPROXIMATE AMERICAN WATER WORKS ASSOCIATION	MAX MFG MIN MIP MJ	MAXIMUM MANUFACTURER MINIMUM MALLEABLE IRON PIPE MECHANICAL JOINT
AVHCWD	APPLE VALLEY HEIGHTS COUNTY WATER DISTRICT	N No. (OR #) NTS	NORTH NUMBER NOT TO SCALE
BF	BLIND FLANGE		
CA CAV	CALIFORNIA COMBINATION AIR AND VACUUM VALVE	O.D. OH OSHA	OUTSIDE DIAMETER OVERHEAD OCCUPATIONAL SAFETY AND HEALTH ADMINISTRATION
CL CONC CONN CMP CY CMRS	CENTERLINE CONCRETE CONNECT/CONNECTION CORRUGATED METAL PIPE CUBIC YARDS COUNTY MAINTENANCE ROAD SYSTEM	PC PCC PE PH PI PIP	POINT OF CURVATURE POINT OF COMPOUND CURVE PLAIN END POT HOLE POINT OF INTERSECTION PROTECT IN PLACE
DEFL DEG DEMO DET DI, DIP DIPS DIA	DIAMETER	PL PO PP PSI PT PVC PWR	PROPERTY LINE PUSH ON POWER POLE POUNDS PER SQUARE INCH POINT, POINT OF TANGENCY POLYVINYL CHLORIDE POWER
DWG(S) DWY	DRAWING(S) DRIVEWAY	RAD ROW	RADIUS RIGHT OF WAY
E EA ELEC EOP ETW EX	EAST EACH ELECTRIC EDGE OF PAVEMENT EDGE OF TRAVEL WAY EXISTING	S S.B.CO. SBCFCD SBCSD SCE SF	SLOPE, SOUTH SAN BERNARDINO COUNTY S.B.CO. FLOOD CONTROL DISTRICT SAN BERNARDINO COUNTY SPECIAL DISTRICTS SOUTHERN CALIFORNIA EDISON SQUARE FEET
FCA FLG FO FH FT (OR ') F&I	FLANGED COUPLING ADAPTER FLANGE FIBER OPTIC FIRE HYDRANT FEET FURNISH AND INSTALL	SFT SHT SPEC(S) SST STA STD STL	SURVEY FEET SHEET SPECIFICATION(S) STAINLESS STEEL STATION STANDARD STEEL
G GV	GAS GATE VALVE	SWG	SOUTHWEST GAS
H, HORIZ HDG HDPE	HORIZONTAL HOT DIP GALVANIZED HIGH DENSITY POLYETHLYENE	TB TEL/TELCO TOP TYP	THRUST BLOCK TELEPHONE/TELECOMMUNICATION TOP OF PIPE TYPICAL
ID	INSIDE DIAMETER	U.S.A.	UNITED STATES OF AMERICA

DATE | REVISIONS:

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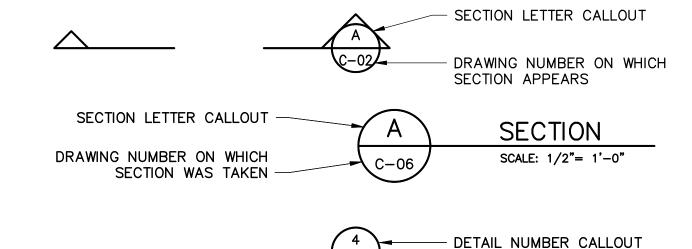
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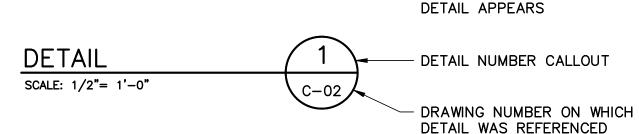
WEST, WATER

LEGEND

EX. MONUMENT	•
EX. WATER VALVE	\otimes
EX. WATER METER	W
EX. FIRE HYDRANT	+O+
EX. POWER POLE	
EX. WIRE FENCE	
EX CENTERLINE	
EX. RIGHT OF WAY	
EX. SECTION LINE/PROPERTY LINE	
EX. EASEMENT	
EX. WATER LINE	w
EX. ELECTRICAL CONDUIT	——— Е
PROPOSED EASEMENT	
PROPOSED PIPELINE	20+00
PROPOSED TELCO CONDUIT	тт
PROPOSED DRY BARREL FIRE HYDRANT	$\blacktriangleleft\!$
PIPE, STRUCTURE, ETC. TO BE ABANDONED (PIPES ENDS TO BE PLUGGED)	

SECTION AND DETAIL DESIGNATION





BASIS OF ELEVATION

ELEVATIONS ARE REFERENCED TO NAVD88, AND DETERMINED LOCALLY BY OBSERVATION OF BENCHMARK M 327 (PID EV1642) PER NGS.

THE NAVD88 ELEVATION = 3425.05 sft

BENCHMARK

THE BENCHMARK IS A 2.5" BRASS DISK, STAMPED "M 327 1935" SET IN A CONCRETE POST 275 FEET NORTH OF THE CENTERLINE OF OCOTILLO WAY, AND EAST OF THE INTERSECTION OF VALLEY VISTA AVE.

DRAWING NUMBER ON WHICH

BASIS OF BEARINGS

BEARINGS ARE REFERENCED TO GRID NORTH AS DEFINED BY THE CALIFORNIA COORDINATE SYSTEM 1983, ZONE V AND ARE BASED ON THE CALCULATED LINE FROM POINT NALO TO POINT YUJO (POINT ID EV2858), SAID BEARING = $N88^{\circ}-51'-09$ "E.

BASIS OF COORDINATES

THE COORDINATES ARE REFERENCED TO THE NORTH AMERICAN DATUM OF 1983 AND ARE EXPRESSED IN TERMS OF THE CALIFORNIA COORDINATE SYSTEM 1983, ZONE V, AT EPOCH 1991.35, AND ARE BASED ON POINT NALO (POINT ID EV2860) PER PUBLISHED NGS CONTROL

THE GRID VALUE FOR NALO = N-2005514.73 sft, E-6805380.95 sft. THE GRID VALUE FOR YUJO = N-2005730.56 sft, E-6816156.49 sft.

DATE OF INITIAL SURVEY JANUARY 11, 2018 BY INLAND AERIAL SURVEYS, INC.

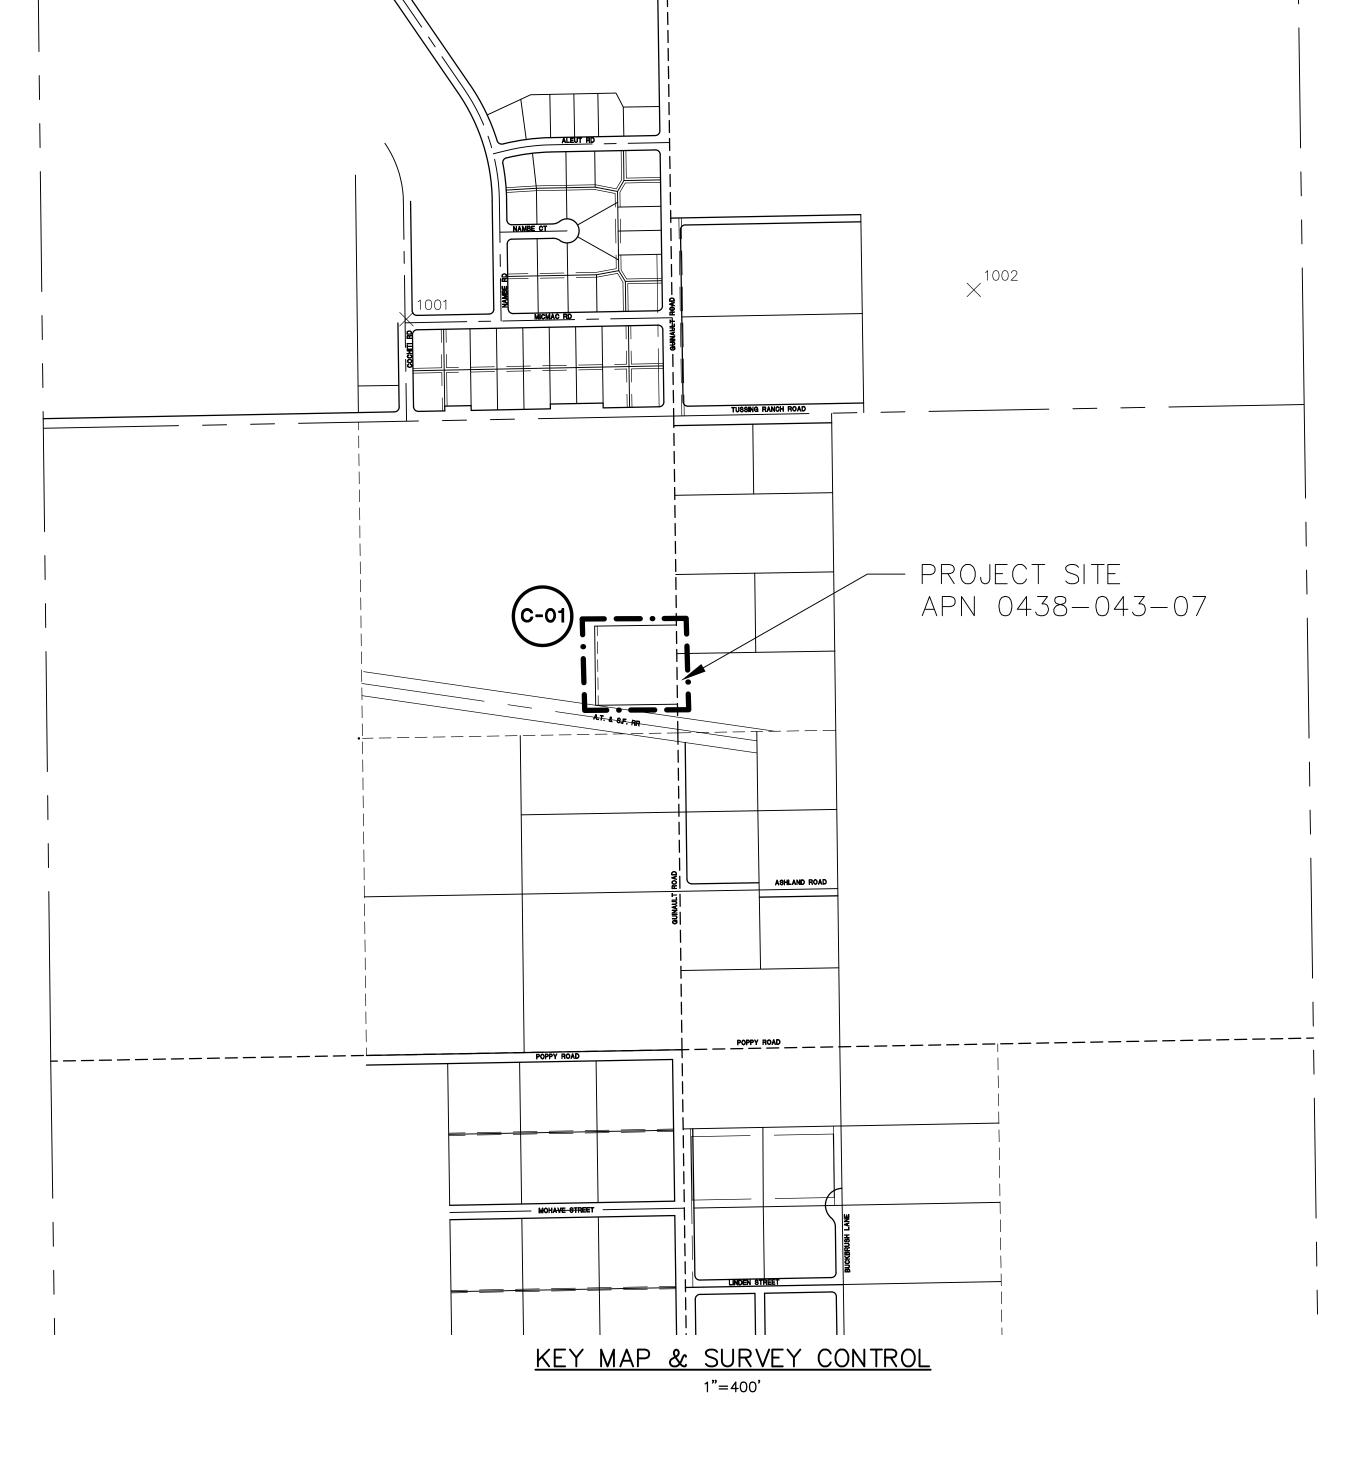
REFERENCE DRAWING

SBCSD H-3A&B THRUST BLOCKS SBCSD H-3C&D STANDARD RESTRAINT TEES, DEAD ENDS & BENDS FOR PVC C900 SBCSD H-6 AIR AND VACUUM VALVE ASSEMBLY SBCSD H-7A 4" & 6" BLOWOFF ASSEMBLY FOR A.C. & P.V.C. MAINS SBCSD H-10A&B 6" & 8" PRESSURE REDUCING STATION SBCSD H-15 TRENCH REPAIR IN ROADS SBCSD TYPICAL TRENCH DETAIL H-16

GEOTECHNICAL INVESTIGATION REPORT

GEOTECHNICAL INVESTIGATION REPORT NV5 WEST (NV5) APPLE VALLEY HEIGHTS COUNTY WATER DISTRICT APPLE VALLEY, CALIFORNIA PROJECT NO. 226817-0000211.01 DATED: MAY 24, 2018

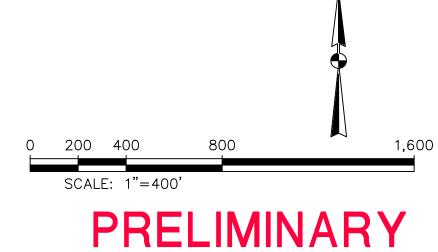
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CONTROL POINTS

POINT NO.	NORTHING	EASTING	ELEVATION	DESCRIPTION
1001	1984871.018	6807372.375	3052.739	FX-1 / 60D W/ WASHER
1002	1984992.862	6809736.340	3079.594	FX-2 / 60D W/ WASHER
30005	1976497.416	6805979.966	3155.460	W 1/4 COR SEC. 22 2IN IP BRASS CAP LS 3980
30006	1976522.354	6807287.762	3171.580	CEN WEST 1/16 COR SPIKE & WASHER COUNTY SURVEYOR
NALO	2005514.730	6805380.950	2950.780	NGS PID EV2860 STAMPED NALO 1979
YUJO	2005730.560	6816156.490	2933.070	NGS PID EV2858 STAMPED YUJO 1979

*POINTS 30005, 30006, NALO & YUJO OUTSIDE OF KEY MAP VIEWABLE AREA



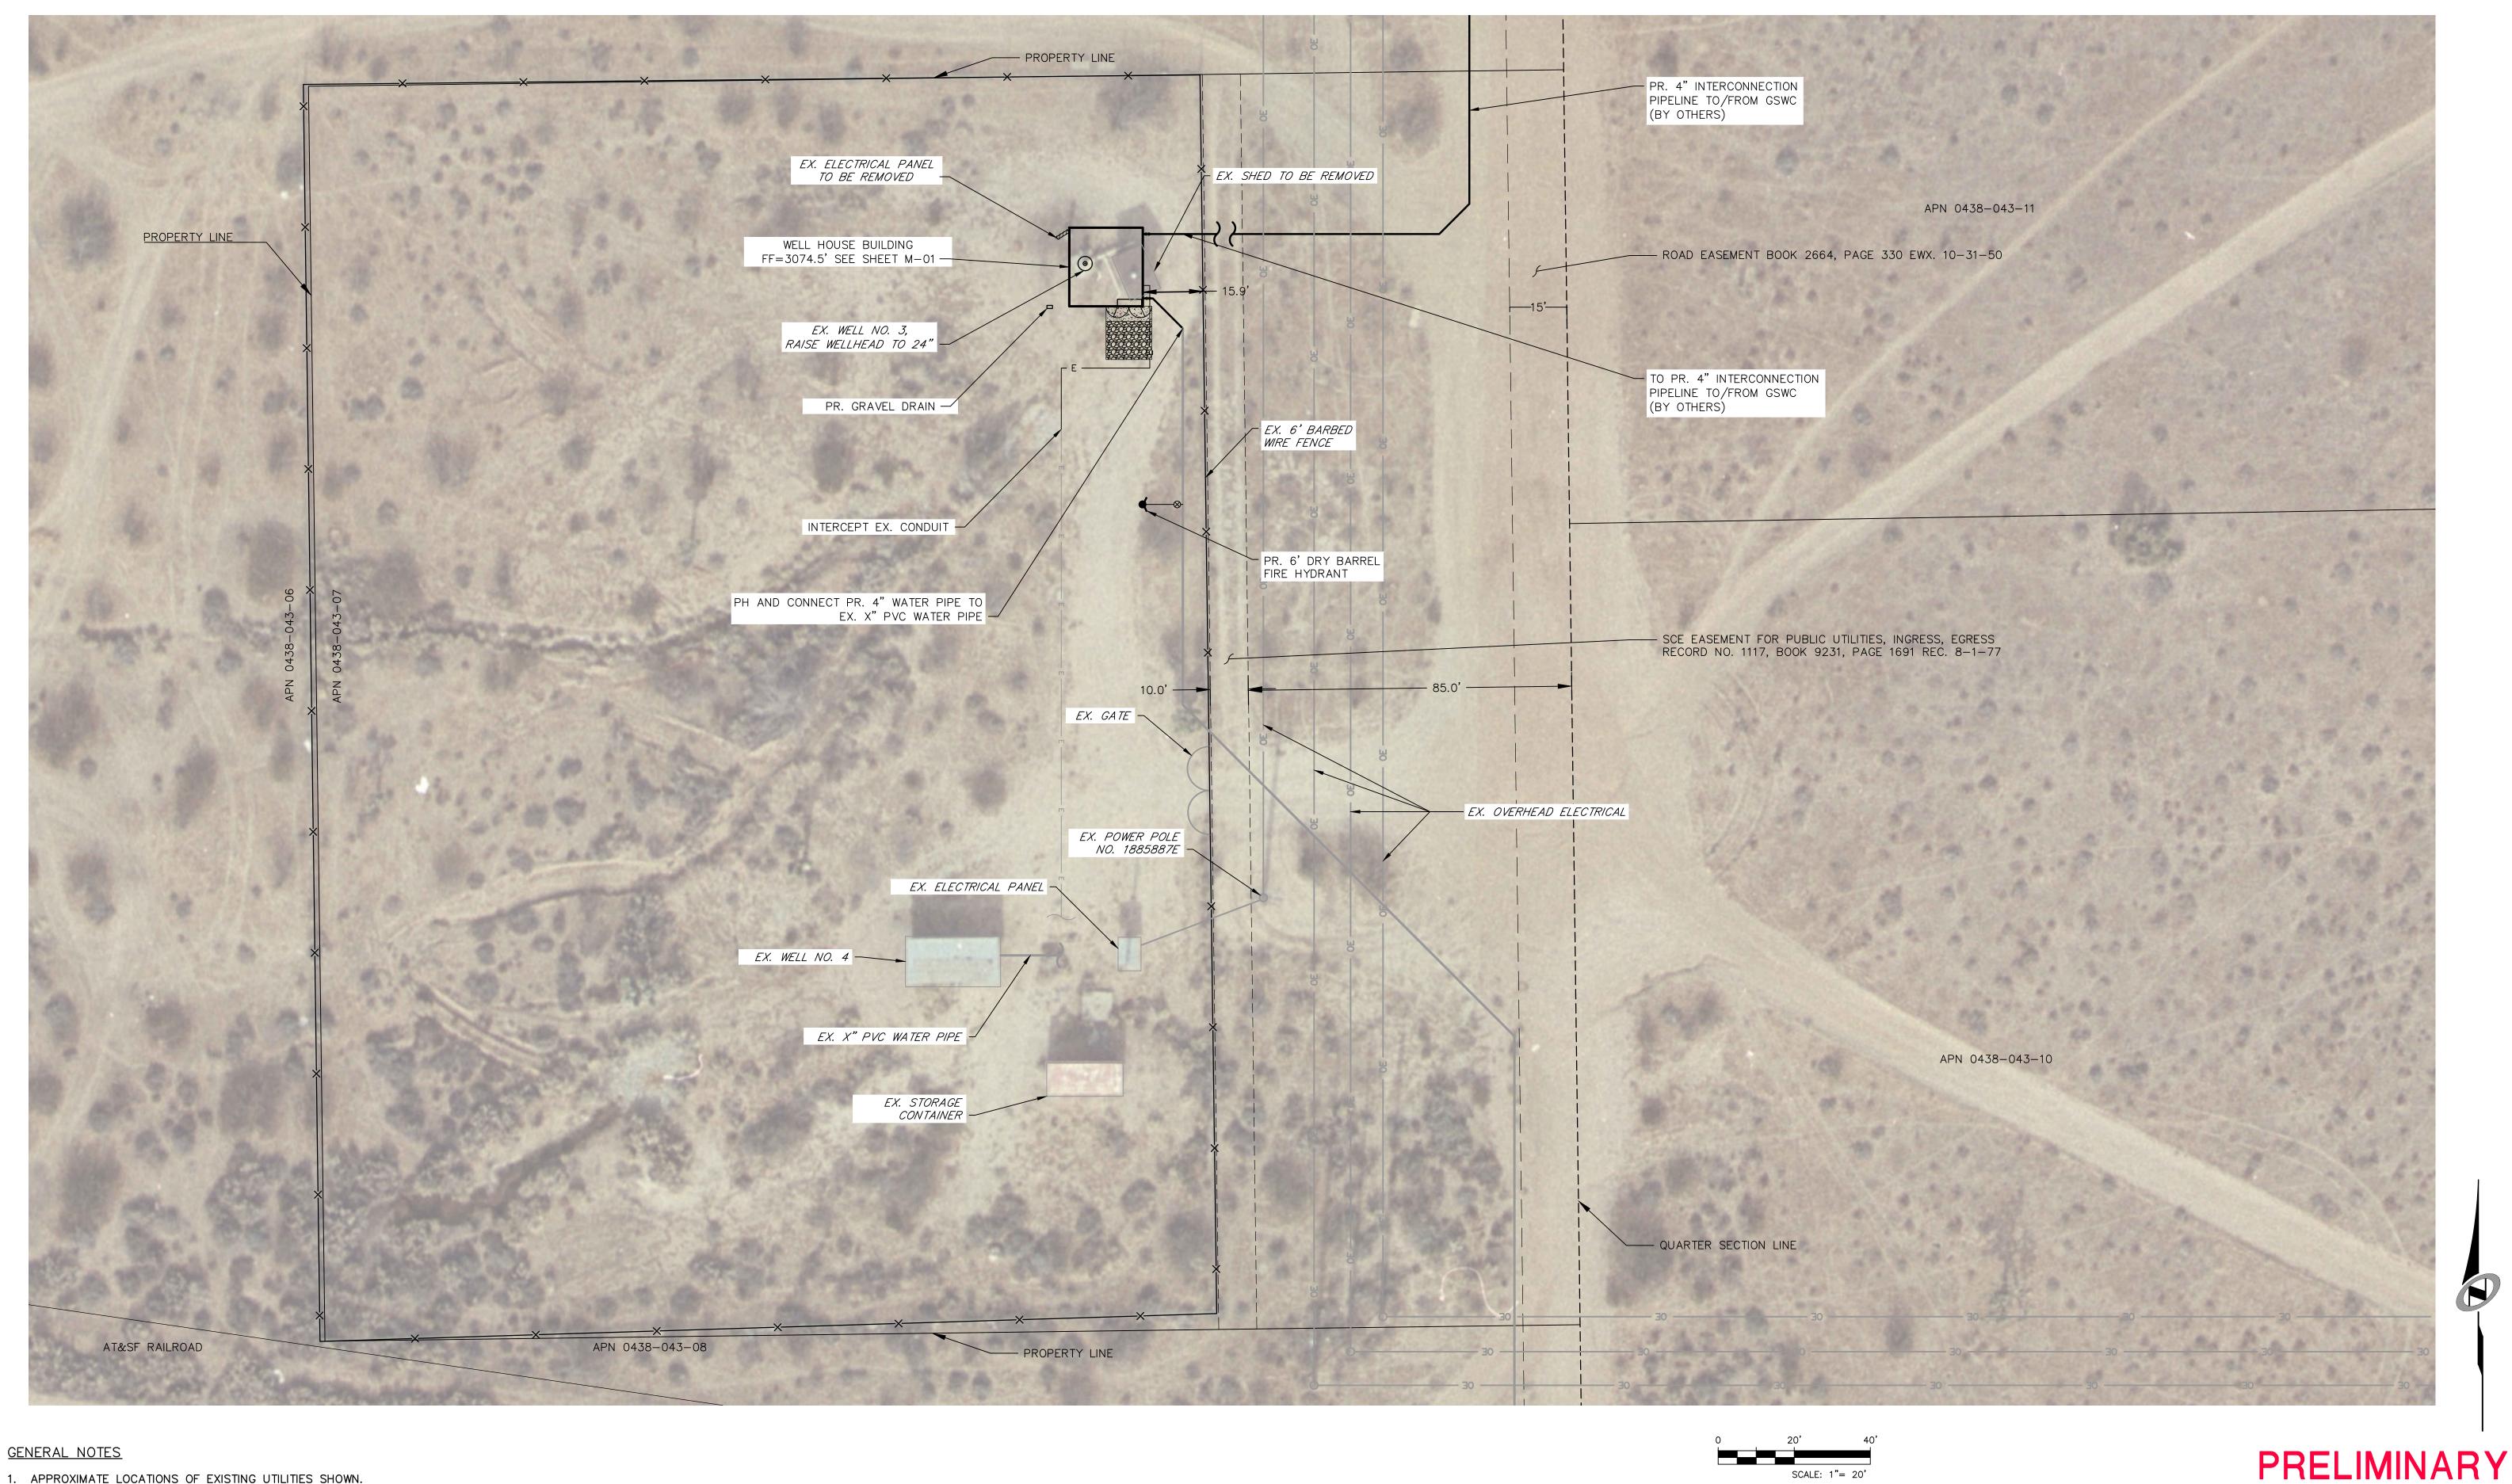
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WELL AND BOOSTER PUMP STATION IMPROVEMENTS NOTES LEGEND ABBREVIATIONS KEY MAP & SURVEY CONTROL

G-01 **2** OF **4** SHEETS SCALE VERTICAL: 1"=N/AHORIZONTAL: 1"= 400'

PREPARED FOR: APPLE VALLEY HEIGHTS COUNTY WATER DISTRICT

DATE SUBMITTED: SEPTEMBER 2019 226817-0000211.03



GENERAL NOTES

1. APPROXIMATE LOCATIONS OF EXISTING UTILITIES SHOWN.

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WELL AND BOOSTER PUMP STATION IMPROVEMENTS SITE PLAN

VERTICAL: 1"=N/AHORIZONTAL: 1"=20'

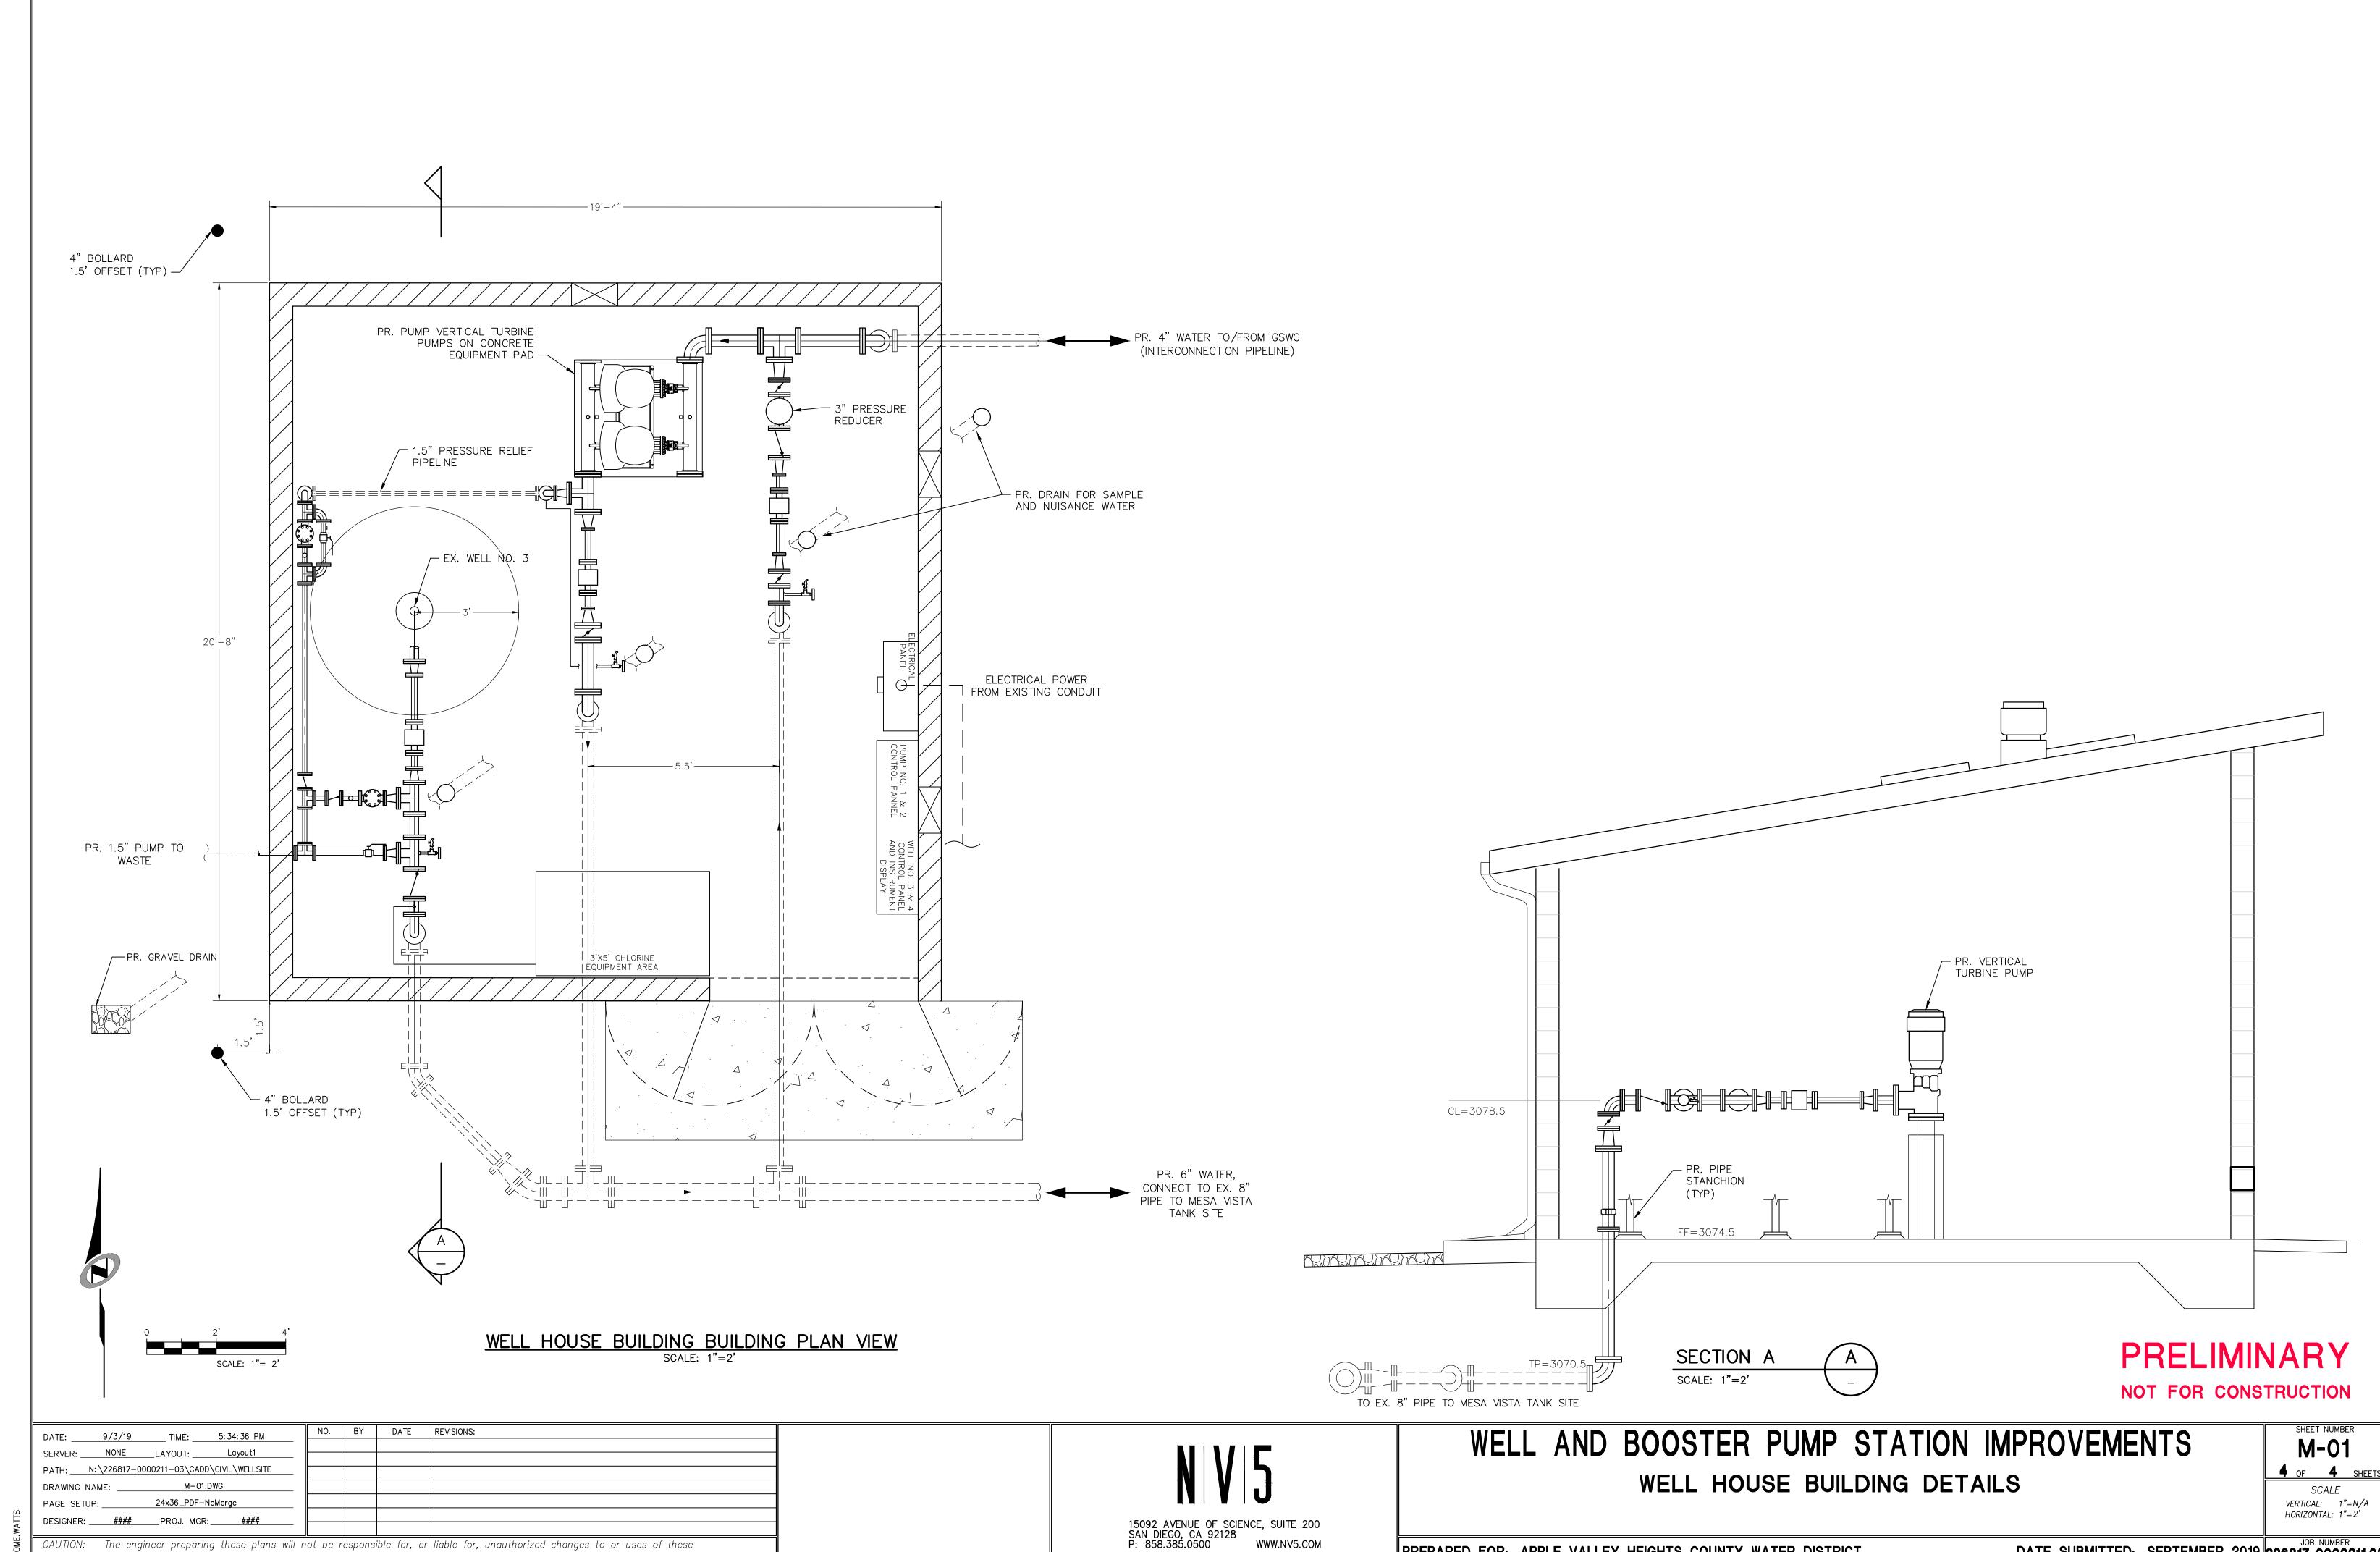
PREPARED FOR: APPLE VALLEY HEIGHTS COUNTY WATER DISTRICT

DATE SUBMITTED: SEPTEMBER 2019 226817-0000211.03

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