

APPLE VALLEY HEIGHTS COUNTY WATER DISTRICT MESA VISTA POTABLE WATER STORAGE TANK REPLACEMENT

60% SUBMITTAL OCTOBER 2019

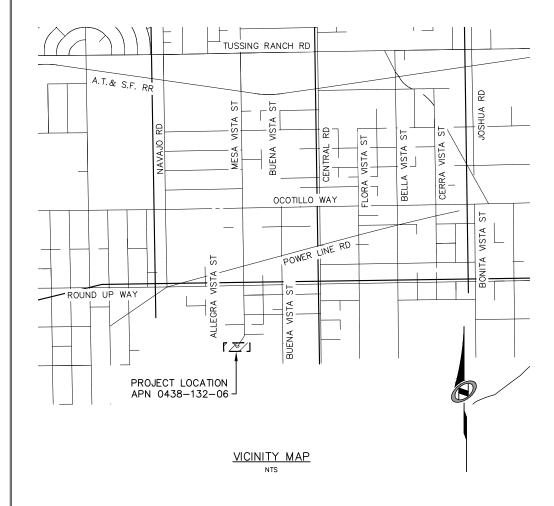

SHEET INDEX

SHEET	DWG.	
NO:	<u>NO:</u>	DRAWING TITLE:
1	T-01	TITLE SHEET
2	G-01	NOTES, LEGEND, ABBREVIATIONS & SURVEY CONTROL
3	C-01	EXISTING SITE PLAN AND DEMOLITION PLAN
4	C-02	SITE PLAN AND YARD PIPING
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LOCATION MAP

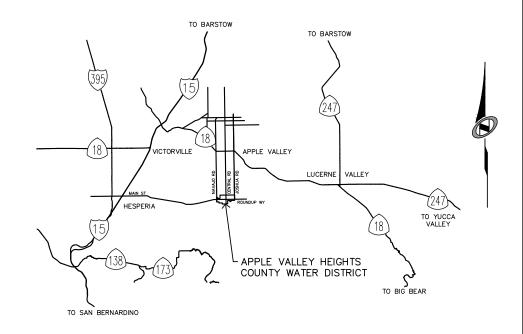







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DATE: 10/8/19 TIME: 2:32:08 PM	NO.	BY	DATE	REVISIONS:				
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				liable for, unauthorized changes to or uses of these				
plans. All changes to the plans must be in writing and must be approved by the preparer of these plans.								



<i>I</i> ESA	VISTA	POTABLE	WATER	STORAGE	TANK	REPLACEMENT
			TITLE	SHEET		

T-01

PREPARED FOR: APPLE VALLEY HEIGHTS COUNTY WATER DISTRICT

GENERAL NOTES

- 1 POTABLE WATER WORKS SHALL BE CONSTRUCTED IN ACCORDANCE WITH THE DETAILS AND MATERIALS AS SPECIFIED HEREIN AND PER THE CURRENT STANDARDS OF THE AMERICAN WATERWORKS ASSOCIATION (AWWA).
- UNLESS OTHERWISE NOTED, CONNECTIONS TO EXISTING PIPELINES SHALL BE MADE DRY. THE TIME AND DURATION OF ANY SHUTDOWNS OF EXISTING MAINS SHALL BE SUBJECT TO APPROVAL BY THE OWNER. OWNER SHALL BE NOTIFIED FIVE WORKING DAYS MINIMUM IN ADVANCE OF ANY SHUTDOWN. SYSTEM VALVES WILL BE
- 3. CONTRACTOR SHALL COORDINATE WITH OWNER ALL ARRANGEMENTS FOR HIGH-LINING TEMPORARY SERVICES PRIOR TO SHUTDOWNS. NO SHUTDOWNS WILL BE SCHEDULED ON MONDAY, FRIDAY, HOLIDAY OR WEEKENDS.
- 4. NO WORK MAY BEGIN OR PROCEED WITHOUT DIRECTION OF OWNER'S INSPECTOR. CONTRACTOR SHALL NOTIFY THE OWNER'S INSPECTOR 48 HOURS PRIOR TO THE BEGINNING OF WORK TO ARRANGE FOR INSPECTION OF THE PROJECT.
- 5. THE CONTRACTOR MUST CALL "DIG ALERT OF SOUTHERN CALIFORNIA" TO HAVE UNDERGROUND SERVICE UTILITIES LOCATED PRIOR TO CONSTRUCTION. THIS CALL WILL BE MADE AT LEAST 48 HOURS IN ADVANCE PRIOR TO ANY WORK BEING PERFORMED IN PUBLIC RIGHT-OF-WAY. (DIG ALERT PHONE: 8-1-1)
- 6. ALL EXISTING FACILITIES WHICH MAY AFFECT PROJECT CONSTRUCTION, I.E., LINE CROSSINGS, LINE PARALLELING, OR PROPOSED CONNECTIONS SHALL BE FIELD VERIFIED BEFORE ANY CONSTRUCTION BEGINS.
- CONTRACTOR SHALL TIE OFF ALL VALVE LOCATIONS AND PROVIDE WRITTEN DIMENSIONS TO INSPECTOR IMMEDIATELY UPON INSTALLATION OF VALVES.
- 8. ALL DESIGN CHANGES TO THE WATER SYSTEM SHALL BE APPROVED BY THE OWNER'S REPRESENTATIVE IN WRITING PRIOR TO CONSTRUCTION AND ACCEPTANCE OF THE CHANGE.
- 9. THE WATER SYSTEM SHALL BE PRESSURE TESTED AND DISINFECTED IN ACCORDANCE WITH THE PROCEDURES
- 10. PIPELINES AND APPURTENANCES SHALL BE DISINFECTED IN ACCORDANCE WITH THE PROJECT SPECIFICATIONS PRIOR TO TIE-IN OR CONNECTION TO EXISTING SYSTEM FACILITIES. BACTERIOLOGIC QUALITY TEST RESULTS SHALL CONFORM TO THE CRITERIA SPECIFIED IN THAT SPECIFICATION.
- 11. CONTRACT RECORD DRAWINGS MUST BE SUBMITTED PRIOR TO FINAL ACCEPTANCE OF WORK. THE PLANS MUST PROVIDE POST CONSTRUCTION VERIFICATION OF THE LOCATION AND ELEVATION OF PIPES AND
- 12. CONTRACTOR SHALL GUARANTEE ALL WORK FOR A PERIOD OF ONE (1) YEAR AFTER THE DATE OF ACCEPTANCE FOR THE PROJECT. CONTRACTOR SHALL REPAIR OR REPLACE ANY OR ALL SUCH WORK, TOGETHER WITH ANY OTHER WORK WHICH MAY BE DISPLACED IN SO DOING THAT MAY PROVE DEFECTIVE IN WORKMANSHIP AND/OR MATERIALS WITHIN THE ONE—YEAR PERIOD FROM THE OF ACCEPTANCE WITHOUT EXPENSE WHATSOEVER TO THE OWNER, ORDINARY WEAR AND TEAR, UNUSUAL ABUSE OR NEGLECT EXCEPTED.
- 13. CONTRACTOR SHALL KEEP ACCESS TO DRIVEWAYS AND PRIVATE ROADS OPEN AT ALL TIMES DURING CONSTRUCTION. CONTRACTOR SHALL KEEP NON-SKID STEEL PLATES ONSITE TO COVER EXPOSED TRENCHES AND PROVIDE IMMEDIATE VEHICULAR OR PEDESTRIAN ACCESS.
- 14. CONSTRUCTION SEQUENCING AND FACILITY SHUTDOWN LIMITATIONS ARE ESSENTIAL TO THE EXECUTION OF THE WORK. SEE PROJECT SPECIFICATIONS.
- 15. CONNECTIONS TO EXISTING ASBESTOS CEMENT PIPE SHALL BE MADE BY DISASSEMBLING THE EXISTING AC PIPE JOINT AND NOT CUTTING THE AC PIPE. PROVIDE NEW PVC PIPE SPOOLS AS REQUIRED TO COMPLETE
- 16. ANY PLANNED WATER SYSTEM OUTAGES DURING THE ERECTION OF THESE IMPROVEMENTS WILL BE COORDINATED WITH AVHCWD TWO WEEKS MINIMUM PRIOR TO PROPOSED SHUT DOWN. NO SHUT DOWN SHALL OCCUR WITHOUT AUTHORIZATION OF AVHCWD. CONTRACTOR SHALL ANTICIPATE HANG NO LESS THAN ONE TANK IN OPERATION AND CONNECTED TO THE WATER SUPPLY AND AVHCWD CUSTOMERS AT ALL TIMES.

ABBREVIATIONS

DATE: ______10/8/19 ____TIME: _____2:32:16 PM

_LAYOUT: _ PATH:N: \226817-0000211-03\CADD\CIVIL\MESA VISTA TANKS

G-01.DWG

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AB	AGGREGATE BASE	MAX	MAXIMUM
AC	ASBESTOS CEMENT	MFG	MANUFACTURER
ALT	ALTERNATE	MIN	MINIMUM
ANG	ANGLE	MIP	MALLEABLE IRON PIPE
APPROX	APPROXIMATE	MJ	MECHANICAL JOINT
AWWA	AMERICAN WATER WORKS ASSOCIATION	N	NORTH
AVHCWD	APPLE VALLEY HEIGHTS COUNTY WATER	No. (OR #)	NUMBER
	DISTRICT	NTS (SIX #)	NOT TO SCALE
BF	BLIND FLANGE	0.D.	OUTSIDE DIAMETER
CA CA	CALIFORNIA	OH.	OVERHEAD
CAV	COMBINATION AIR AND VACUUM VALVE	OSHA	OCCUPATIONAL SAFETY AND
CL	CENTERLINE	OSHA	HEALTH ADMINISTRATION
CONC	CONCRETE	PC	POINT OF CURVATURE
CONN	CONNECT/CONNECTION	PCC	POINT OF COMPOUND CURVE
CMP	CORRUGATED METAL PIPE	PE	PLAIN END
CY	CUBIC YARDS	PH	POT HOLE
CMRS	COUNTY MAINTENANCE ROAD SYSTEM	PI	POINT OF INTERSECTION
DEFL	DEFLECTION	PIP	PROTECT IN PLACE
DEG	DEGREE	PL	PROPERTY LINE
		PO	PUSH ON
DEMO	DEMOLISH/DEMOLITION	PP	POWER POLE
DET	DETAIL	PSI	POUNDS PER SQUARE INCH
DI, DIP	DUCTILE IRON, DUCTILE IRON PIPE	PT	POINT, POINT OF TANGENCY
DIPS	DUCTILE IRON PIPE SIZE	PVC	
DIA	DIAMETER	PWR	POLYVINYL CHLORIDE POWER
DWG(S)	DRAWING(S)	RAD	RADIUS
DWY '	DRIVEWAY	ROW	RIGHT OF WAY
Ε.	EAST	S	SLOPE, SOUTH
EA	EACH	S.B.CO.	SAN BERNARDINO COUNTY
ELEC	ELECTRIC	SBCFCD	S.B.CO. FLOOD CONTROL DISTRICT
EOP	EDGE OF PAVEMENT	SBCSD	SAN BERNARDINO COUNTY SPECIAL DISTRICTS
ETW	EDGE OF TRAVEL WAY	SCE	SOUTHERN CALIFORNIA EDISON
EX	EXISTING	SF.	SQUARE FEET
FCA	FLANGED COUPLING ADAPTER	SFT	SURVEY FEET
FLG	FLANGE	SHT	SHEET
FO	FIBER OPTIC		
FH	FIRE HYDRANT	SPEC(S)	SPECIFICATION(S)
FT (OR ')	FEET	SST	STAINLESS STEEL
F&I	FURNISH AND INSTALL	STA	STATION
G	GAS	STD	STANDARD
GV	GATE VALVE	STL	STEEL
H, HORIZ	HORIZONTAL	SWG	SOUTHWEST GAS
HDG	HOT DIP GALVANIZED	TB	THRUST BLOCK
HDPE	HIGH DENSITY POLYETHLYENE	TEL/TELCO	TELEPHONE/TELECOMMUNICATION
ID	INSIDE DIAMETER	TOP	TOP OF PIPE
IE	INVERT ELEVATION	TYP	TYPICAL
IN (OR ")	INCHES	U.S.A.	UNITED STATES OF AMERICA
LF `´´	LINEAR FEET	W	WEST, WATER


LEGEND

EX. MONUMENT EX. WATER VALVE EX. WATER METER EX. FIRE HYDRANT EX. POWER POLE EX. WIRE FENCE EX CENTERLINE EX. RIGHT OF WAY EX. SECTION LINE/PROPERTY LINE EX. EASEMENT EX. ELECTRICAL CONDUIT PROPOSED PIPELINE PROPOSED OVERHEAD ELECTRICAL PROPOSED TELCO CONDUIT \otimes PROPOSED GATE VALVE

PIPE, STRUCTURE, ETC. TO BE ABANDONED (PIPES ENDS TO BE PLUGGED)

p----APPLE VALLEY HEIGHTS COUNTY WATER DISTRICT SERVICE AREA

SECTION AND DETAIL DESIGNATION

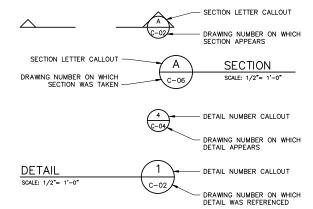

BASIS OF ELEVATION

ELEVATIONS ARE REFERENCED TO NAVD88, AND DETERMINED LOCALLY BY OBSERVATION OF

THE NAVD88 ELEVATION = 3425.05 sft

BENCHMARK

THE BENCHMARK IS A 2.5" BRASS DISK, STAMPED "M 327 1935" SET IN A CONCRETE POST 275 FEET NORTH OF THE CENTERLINE OF OCOTILLO WAY, AND EAST OF THE INTERSECTION OF VALLEY VISTA AVE.

BASIS OF BEARINGS

BEARINGS ARE REFERENCED TO GRID NORTH AS DEFINED BY THE CALIFORNIA COORDINATE SYSTEM 1983, ZONE V AND ARE BASED ON THE CALCULATED LINE FROM POINT NALO TO POINT YUJO (POINT ID EV2858), SAID BEARING = N88-51'-09"E.


BASIS OF COORDINATES

THE COORDINATES ARE REFERENCED TO THE NORTH AMERICAN DATUM OF 1983 AND ARE EXPRESSED IN TERMS OF THE CALIFORNIA COORDINATE SYSTEM 1983, ZONE V, AT EPOCH 1991.35, AND ARE BASED ON POINT NALO (POINT ID EV2860) PER PUBLISHED NGS CONTROL.

THE GRID VALUE FOR NALO = N-2005514.73~sft, E-6805380.95~sft. THE GRID VALUE FOR YUJO = N-2005730.56~sft, E-6816156.49~sft.

DATE OF INITIAL SURVEY

JANUARY 11, 2018 BY INLAND AERIAL SURVEYS, INC.

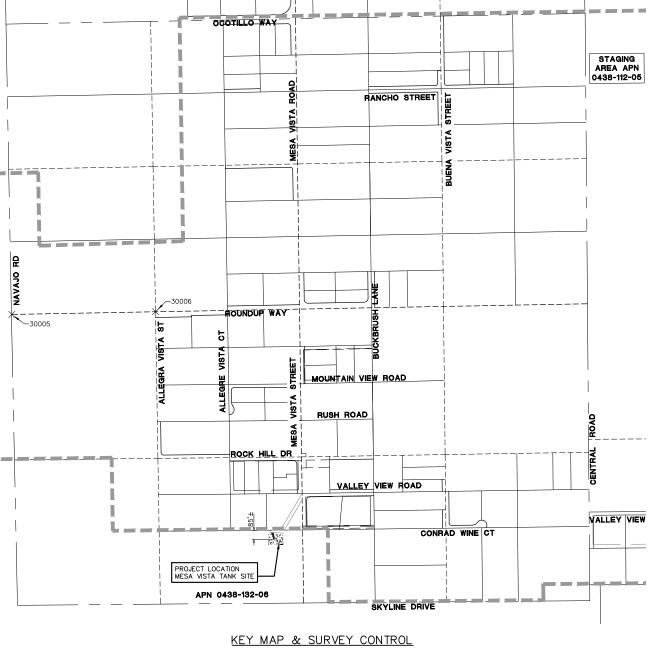


GEOTECHNICAL INVESTIGATION REPORT

GEOTECHNICAL INVESTIGATION REPORT NV5 WEST (NV5)
APPLE VALLEY HEIGHTS COUNTY WATER DISTRICT
APPLE VALLEY, CALIFORNIA
PROJECT NO. 226817–0000211.01
DATED: MAY 24, 2018

CONTROL POINTS

POINT NO.	NORTHING	EASTING	ELEVATION	DESCRIPTION
30005	1976497.416	6805979.966	3155.460	W 1/4 COR SEC. 22 2IN IP BRASS CAP LS 3980
30006	1976522.354	6807287.762	3171.580	CEN WEST 1/16 COR SPIKE & WASHER COUNTY SURVEYOR
NALO	2005514.730	6805380.950	2950.780	NGS PID EV2860 STAMPED NALO 1979
YUJO	2005730.560	6816156.490	2933.070	NGS PID EV2858 STAMPED YUJO 1979

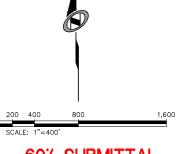

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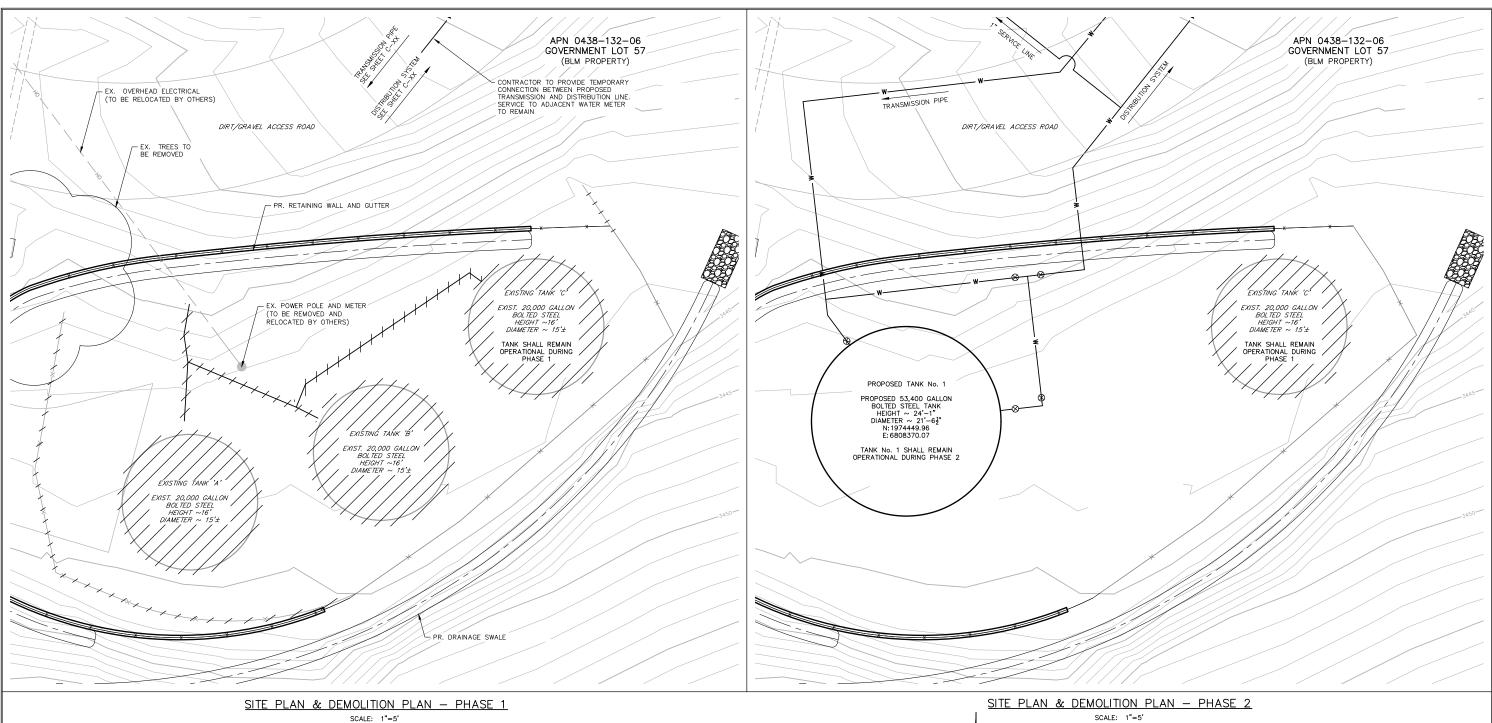
MESA VISTA POTABLE WATER STORAGE TANK REPLACEMENT NOTES LEGEND, ABBREVIATIONS & SURVEY CONTROL

G-01 OF 7 SHEETS SCALE VERTICAL: 1"= NA HORIZONTAL: 1"= 400"

CAUTION: The engineer preparing these plans will not be responsible for, or liable for, unauthorized changes to or uses of these plans. All changes to the plans must be in writing and must be approved by the preparer of these plans.

NO. BY DATE REVISIONS:


PREPARED FOR: APPLE VALLEY HEIGHTS COUNTY WATER DISTRICT



DEMOLITION NOTES

- THE SCOPE OF DEMOLITION WORK SHALL NOT BE LIMITED TO THOSE ITEMS DEFINED ON THE DRAWING, BUT SHALL ALSO INCLUDE FIXTURES, CONDUITS, WIRING, MECHANICAL EQUIPMENT, MISCELLANEOUS CONCRETE, RUBBISH, AND ANY OTHER ITEMS OR MATERIAL NECESSARY FOR THE PERFORMANCE OF THIS CONTRACT.
- 2. THE CONTRACTOR SHALL PROTECT FROM DAMAGE THE EXISTING TANKS AND ANY OTHER PIPING OR EQUIPMENT NOT SUBJECT TO REMOVAL OR REQUIRED TO CONTINUE OPERATION.
- 3. THE CONTRACTOR SHALL BE RESPONSIBLE TO COORDINATE WITH AVHOWD FOR WHICH EQUIPMENT AND APPURTENANCES SHALL BE SALVAGED OR DISPOSED OF AND TO VERIFY THAT ALL LIEMS TO BE SALVAGED ARE IDENTIFIED HEREIN. ITEMS TO BE SALVAGED SHALL BE DISCONNECTED, HANDED WITH CARE SO AS TO AVOID DAMAGE, AND TRANSPORTED TO A LOCATION SPECIFIED BY AVHOWD. STORAGE AREA SHALL BE IDENTIFIED PRIOR TO BEGINNION SALVAGE OPERATIONS, DAMAGE TO ITEMS TO BE ALVAGED THAT IS DIRECTLY ATTRIBUTED TO THE CONTRACTOR'S OPERATIONS SHALL BE REPAIRED OR REPLACED AT THE CONTRACTOR'S FYPENSE
- 4. THE CONTRACTOR SHALL BE REQUIRED TO COORDINATE HIS DEMOLITION WORK WITH THE OPERATION OF THE EXISTING TANKS. THE CONTRACTOR SHALL BE RESPONSIBLE FOR ALL COSTS ASSOCIATED WITH THIS COORDINATION. THE DEMOLITION WORK FOR THIS PROJECT SHALL ALSO INCLUDE THE REMOVAL AND OFF—SITE DISPOSAL OR SALVAGE OR RELOCATION OF CONCRETE, SIGNAGE, PIPING EQUIPMENT, AND OTHER NON-NATIVE MATERIALS FOR THE CONSTRUCTION OF THE PROPOSED TANKS.
- 5. CONTRACTOR SHALL PROVIDE TEMPORARY PIPING TO CONNECT EXISTING TANK 'C' DURING PHASE 1 DEMOLITION AND SITE WORK. CONNECTION BETWEEN AT LEAST 1 TANK AND THE DISTRIBUTION LINE SHALL BE ACTIVE AT ALL TIMES.

- CONTRACTOR SHALL REFER TO CONSTRUCTION SEQUENCING REQUIREMENTS OUTLINED IN SPECIFICATION SECTION 01040.
- ANY PLANNED WATER OUTAGES DURING THE ERECTION OF THESE IMPROVEMENTS WILL BE COORDINATED WITH AVHCWD TWO WEEKS MINIMUM PRIOR TO PROPOSED SHUT DOWN. NO SHUT DOWN SHALL OCCUR WITHOUT AUTHORIZATION OF AVHCWD. CONTRACTOR SHALL ANTICIPATE HAVING NO LESS THAN ONE TANK IN OPERATION AND CONNECTED TO THE WATER SUPPLY AND AVHCWD CUSTOMERS AT ALL TIMES.
- 4. INSTALL DUCTLE IRON FITTINGS AND THRUST BLOCKS ON TEMPORARY PIPING AT ALL BENDS. INSTALL THRUST BLOCKS PER DETAIL 3, DWG. C-05
- 5. DO NOT CONNECT PORTION OF 4" PIPING UNTIL TANK NO. 1A AND ASSOCIATED PIPING AS SHOWN ON C-02 HAVE BEEN INSTALLED, INSPECTED, DISINFECTED, TESTED, AND PLACED INTO SERVICE.

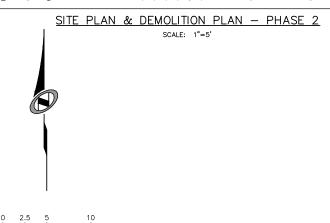

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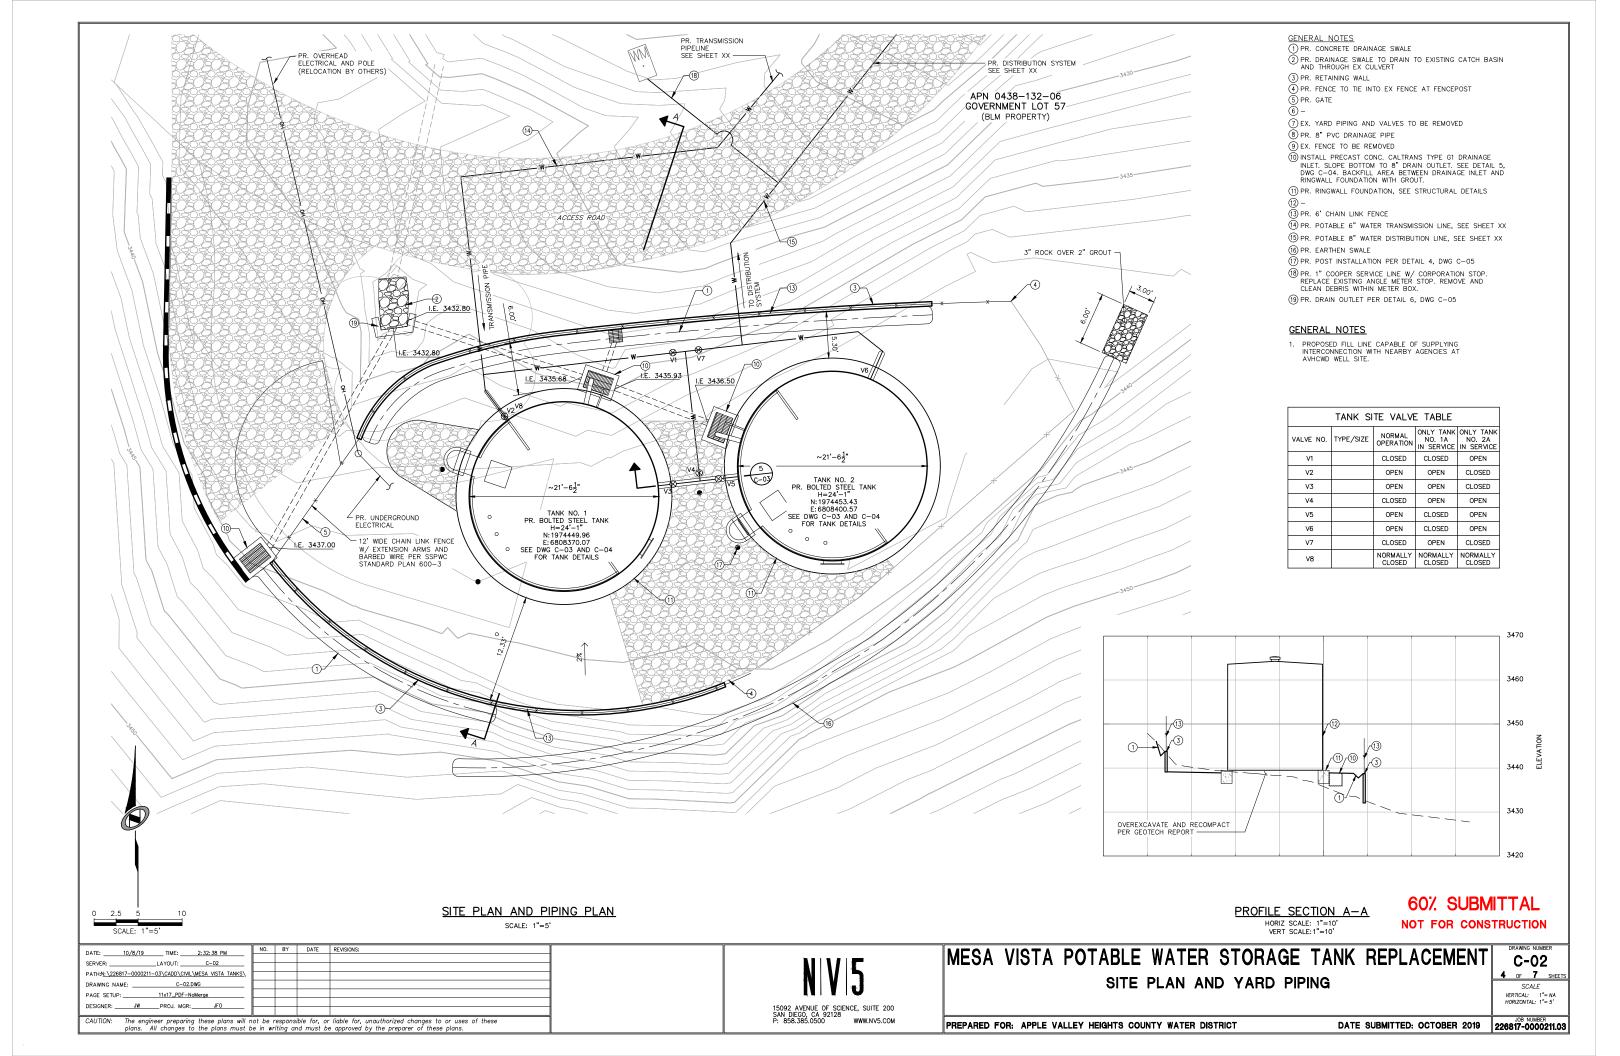
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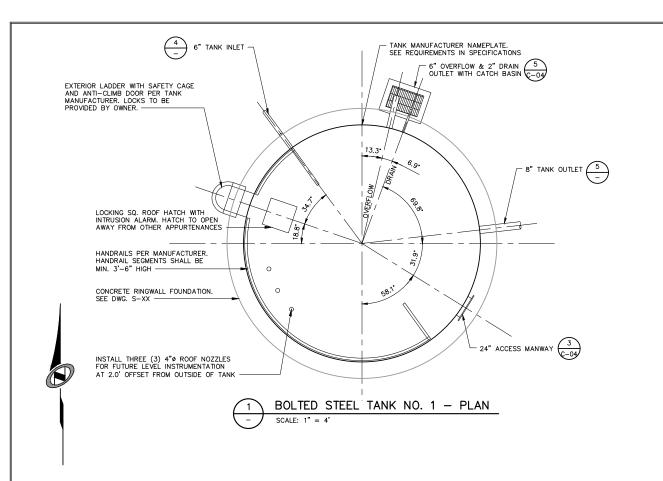
MESA VISTA POTABLE WATER STORAGE TANK REPLACEMENT EXISTING SITE PLAN AND DEMOLITION PLAN


C-01 SCALE


VERTICAL: 1"= NA HORIZONTAL: 1"= 5'

PREPARED FOR: APPLE VALLEY HEIGHTS COUNTY WATER DISTRICT





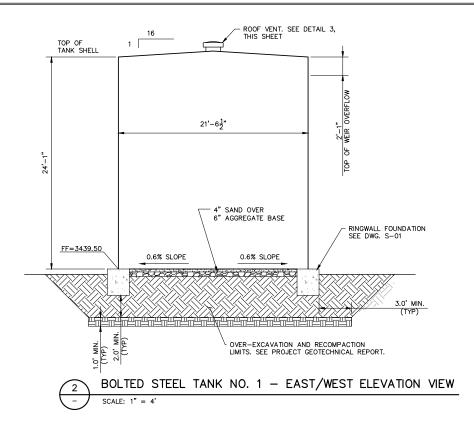


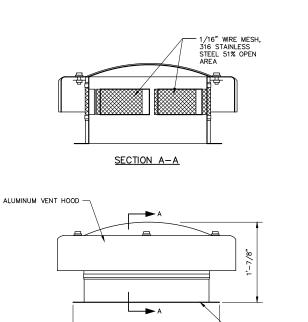


ROOF VENT DETAIL

NOT TO SCALE

1'-11 1/2" O.D.

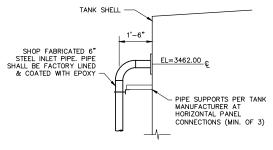

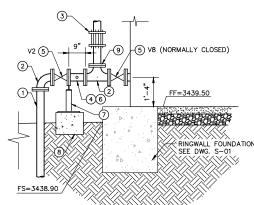


TANK NO. 1

6" INLET CONNECTION DETAIL

NOT TO SCALE


MATERIALS LIST

- 1 6" DI SPOOL, FL. LENGTH AS NEEDED
- ② 6" DI CROSS
- (3) 6" DIAMETER DRESSER STYLE 38 STEEL COUPLING OR APPROVED EQUAL
- 4 6" DI SPOOL PIECE, FL, WITH 1" TAP
- 5 6" GATE VALVE, FL
- 6 SAMPLE TAP 1" NIPPLE & BALL VALVE CORP STOP
- 7 UNDER FLANGE PIPE SUPPORT. SEE DETAIL 5, DWG. C-05
- 8 PIPE SUPPORT CONCRETE BLOCK (18"x18"x12")
- 9 SLIP-ON FLANGE WITH INSULATING FLANGE KIT
- 10 8" BOLTED TANK NOZZLE, FL
- (11) 8" GATE VALVE, FL(12) 8" DI SPOOL, FL, LENGTH AS NEEDED
- (13) 8" DI TEE, FL
- (4) 8" DI 90° ELBOW WITH THRUST BLOCK PER DETAIL 3, DWG. C-05
- (15) 8" DIAMETER DRESSER STYLE 38 STEEL COUPLING OR APPROVED EQUAL
- (6) 6" OF 1" CRUSH ROCK

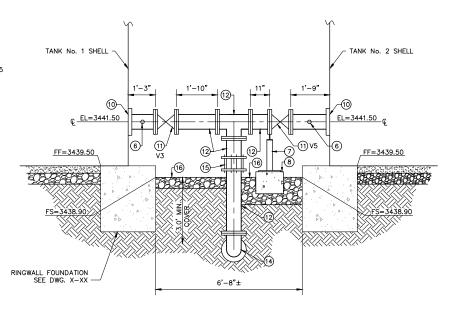

TANK NO. 1 & 2
INTERCONNECTION DETAIL

NOT TO SCALE

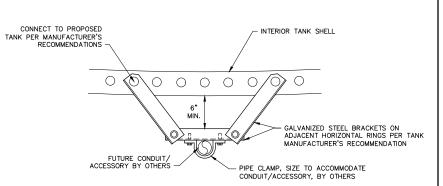

CONDUIT/ACCESSORY

SUPPORTS (TYP OF 4 SETS) TANK 1 ONLY

NOT TO SCALE

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MESA VISTA POTABLE WATER STORAGE TANK REPLACEMENT

TANK DETAILS - 1


T C-03

5 of 7 SHEE

SCALE

VERTICAL: 1"= NA
HORIZONTAL: 1"= NA

PREPARED FOR: APPLE VALLEY HEIGHTS COUNTY WATER DISTRICT DATE SUBMITTED: O

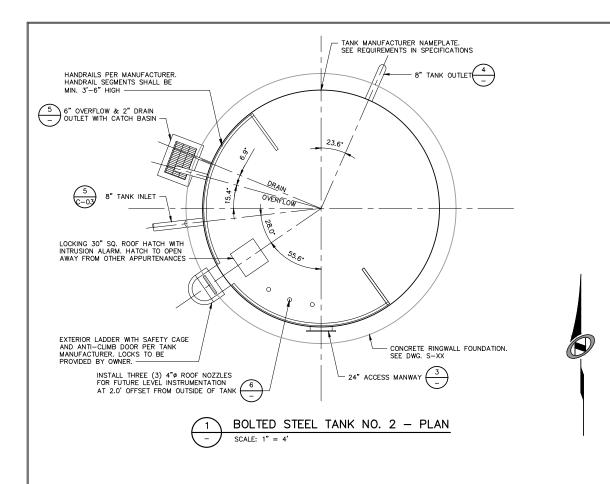


FF=3441.50 C

FF=3439.50


- RINGWALL FOUNDATION SEE DWG. S-01



- 1 8" DI SPOOL, FL. LENGTH AS NEEDED
- 2) 8" DI 90° ELBOW, FL
- (3) 8" DIAMETER DRESSER STYLE 38 STEEL COUPLING OR APPROVED EQUAL
- 4 8" DI 90" ELBOW, FL, WITH 1" FACTORY DRILLED TAP
- 5 8" GATE VALVE, FL W/ INSULATING FLANGE KIT
- 6 8" BOLTED TANK NOZZLE, FL
- 7 8" DI TEE, MJxMJxFL. CONSTRUCT THRUST BLOCK PER DETAIL 3, DWG. C-05
- 8 8" DI SPOOL PIECE, FLxFL
- 9 2" STEEL SPOOL INSTALL SLIP-ON FLANGE WITH INSULATING FLANGE KIT.
- (10) INSTALL 2" GATE VALVE, FL. INSTALL 2-1/2" NH/NST MALE X 2" CARBON STEEL FLANCE (KOCHEK FGM252 OR APPROVED EQUAL) W/ CAP AND CHAIN AT OUTLET.
- (1) INSTALL PRECAST CONC. CALTRANS TYPE G1 DRAINAGE INLET. SLOPE BOTTOM WITH GROUT TO 8" OVERFLOW PIPE OUTLET. SEE DWG. C-02 AND RSP
- (12) INSTALL 1/8" STAINLESS STEEL WOVEN WIRE MESH SCREEN COVERING 6" DRAIN PIPE OPENING. SECURE SCREEN TO PIPE WITH STAINLESS STEEL CLAMPS.
- (13) SAMPLE TAP 1" NIPPLE & BALL VALVE CORP

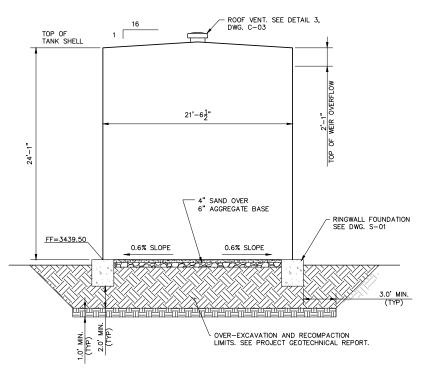


BOLTED STEEL TANK NO. 2 - EAST/WEST ELEVATION VIEW

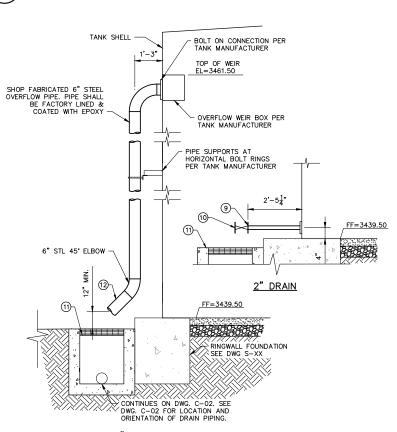


6" OVERFLOW

PROPOSED 6" OVERFLOW AND 2" DRAIN

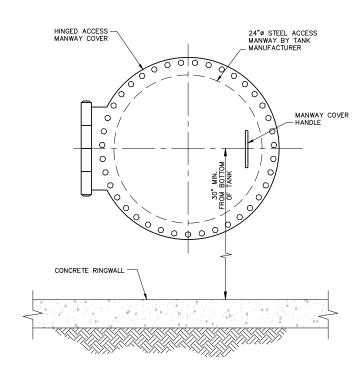

ACCESS MANWAY COVER DETAIL

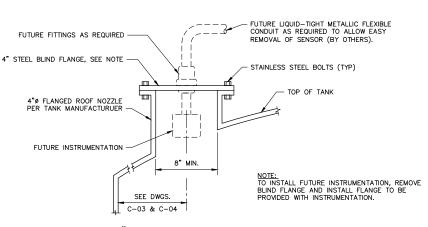

4"ø ROOF NOZZLE FOR FUTURE INSTRUMENTATION (TYP OF 6) NOT TO SCALE

DATE: _____10/8/19 ____TIME: ____2:32:57 PM SERVER: _LAYOUT: _ C-04 PATH:N: \226817-0000211-03\CADD\CIVIL\MESA VISTA TANKS DRAWING NAME: C-04.DWG PAGE SETUP: 11x17_PDF-NoMerge The engineer preparing these plans will not be responsible for, or liable for, unauthorized changes to or uses of these plans. All changes to the plans must be in writing and must be approved by the preparer of these plans.

8" OUTLET CONNECTION DETAIL

TANK SHELL

3)-


TANK NO. 2

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MESA VISTA POTABLE WATER STORAGE TANK REPLACEMENT TANK DETAILS - 2

C-04 OF 7 SHEETS SCALE VERTICAL: 1"= NA HORIZONTAL: 1"= NA

PREPARED FOR: APPLE VALLEY HEIGHTS COUNTY WATER DISTRICT

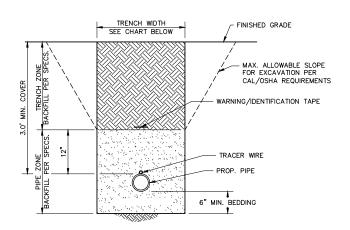


NOTES:

1. EXCAVATE BELL HOLES AT EACH PIPE JOINT TO PERMIT PROPER ASSEMBLY AND INSPECTION OF THE ENTIRE JOINT.

2. ALL PIPELINE TRENCHES SHALL BE EXCAVATED SO THAT THE DISTANCE BETWEEN TRENCH WALLS AT THE TOP OF PIPE SHALL BE AS SHOWN BELOW:


NOMINAL PIPE DIAMETER	MIN. DISTANCE	MAX. DISTANCE
4" & SMALLER	18"	28"
6" & 8"	24"	32"



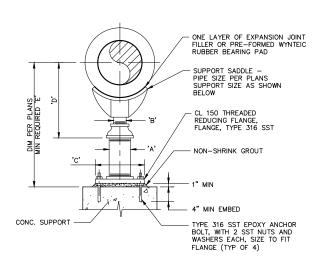

UNDER FLANGE ADJUSTABLE SUPPORT APPROXIMATE DIMENSIONS (INCHES)									
PIPE FLG SPRT A B C D E SIZE OD SIZE A B C D MIN									
4	9.0	8	3	2-1/2	9	13	17		
8	13.5	14	4	3	11	17	22		



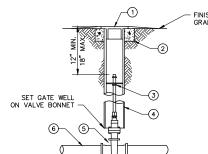

MATERIALS LIST

1 8" DI GATE WELL LID. SEE NOTE 6

(2) 6" HIGH x 6" WIDE (1'-8" OUTSIDE DIAMETER) CONCRETE RING W/ #3 REINF. BAR

3 VALVE STEM EXTENSION, SEE NOTES 1 & 2

4 8" PVC CL235 C-900 PIPE x REQUIRED LENGTH GATE WELL

5 RESILIENT WEDGE GATE VALVE

6 WATER PIPE

NOTES:

1. VALVES DEEPER THAN 5.0' REQUIRE A VALVE STEM EXTENSION


2. EXTENSION STEMS SHALL NOT BE ATTACHED/BOLTED TO OPERATING NUT 3. GATE WELL AND LID SHALL BE SET SO THAT NO MORE THAN TWO 1" ADJUSTMENT RINGS ARE USED

4. GATE WELL LIDS SHALL BE CAST WITH THE AGENCY NAME AND THE WORD WATER



GATE WELL LID

GATE WELL INSTALLATION FOR VALVES 4" AND LARGER

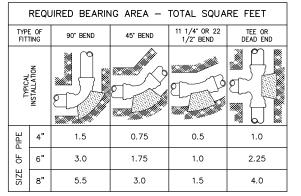

TRANSMISSION PIPELINE

<u>PLAN</u>

CONCRETE ANCHOR BLOCK SEE NOTE 1

D = PIPE DIAMETER

THRUST BLOCKS & VALVE ANCHOR BLOCK

NOTES:

1. THRUST BLOCKS TO BE CONSTRUCTED OF 2500 PSI CONCRETE.

2. AREAS GIVEN ARE FOR TEST PRESSURE OF 100 P.S.I. IN SOIL WITH 2,000 P.S.F. BEARING CAPACITY. BLOCKS TO BE POURED AGAINST UNDISTURBED SOIL.

THRUST BLOCKS ARE REQUIRED AT EVERY ANGLE, TEE, AND CROSS FOR PRESSURIZED PIPE. ANGLES ACHIEVED BY PULLING A BELL AND SPIGOT JOINT WITHIN SPECIFIED TOLERANCES WILL NOT REQUIRE THRUST BLOCKS.

TRENCH WIDTH + 4D

SECTION

- GATE VALVE

ROUNDED CONCRETE 4" DIAMETER GALVANIZED ROUND CONCRETE FINISH GRADE CONC. FOOTING


NOTES:

1. PROTECTION POSTS SHALL BE INSTALLED WHERE INDICATED ON THE DRAWINGS OR AS DIRECTED BY THE CONSTRUCTION MANAGER.

2. PROTECTION POSTS SHALL BE COATED IN SAFETY YELLOW

3. CONCRETE SHALL BE 2,500 PSI MIN.

PROTECTION POST **INSTALLATION DETAIL**

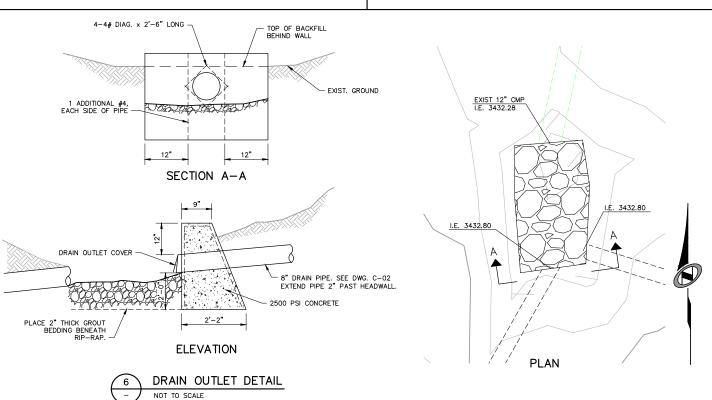

NO. BY DATE REVISIONS: DATE: ______ TIME: _____ 2: 33: 06 PM SERVER: _LAYOUT: _ C-05 PATH:N:\226817-0000211-03\CADD\CIVIL\MESA VISTA TANKS DRAWING NAME: C-05.DWG PAGE SETUP: 11x17_PDF-NoMerge The engineer preparing these plans will not be responsible for, or liable for, unauthorized changes to or uses of these plans. All changes to the plans must be in writing and must be approved by the preparer of these plans.

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MESA VISTA POTABLE WATER STORAGE TANK REPLACEMENT CIVIL DETAILS - 1

C-05 7 OF 7 SHEETS SCALE VERTICAL: 1"= NA HORIZONTAL: 1"= NA

PREPARED FOR: APPLE VALLEY HEIGHTS COUNTY WATER DISTRICT